



ISO A1 594mm x 841mm


Project Management Initials: Designer: AC    Checked: ER    Approved: RG

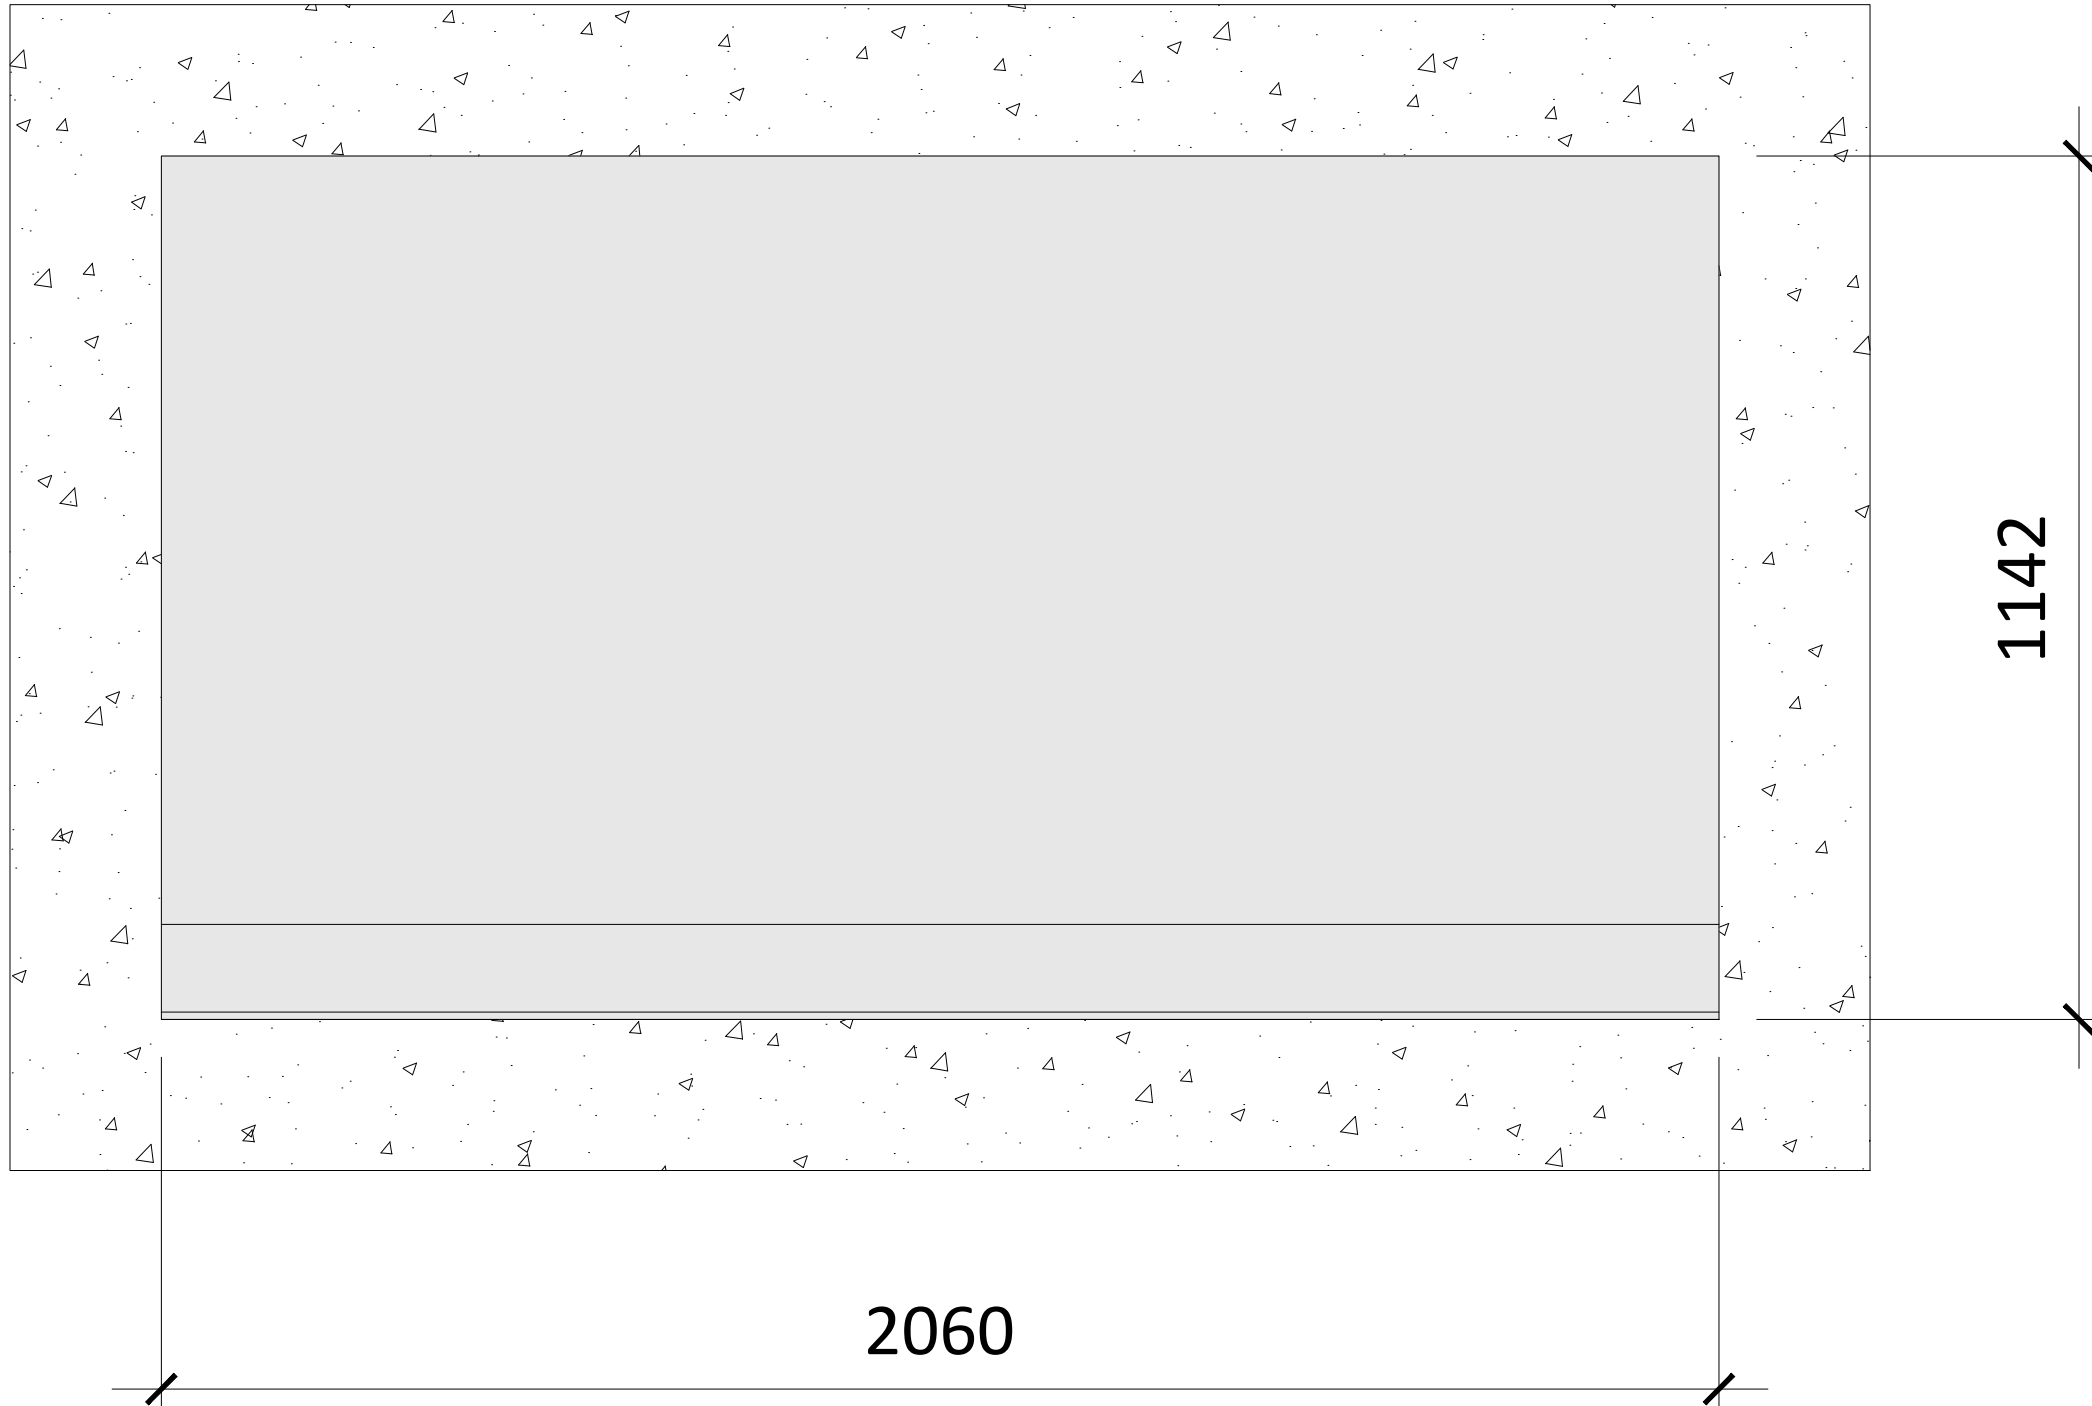

Plan View  
SCALE: 1:10

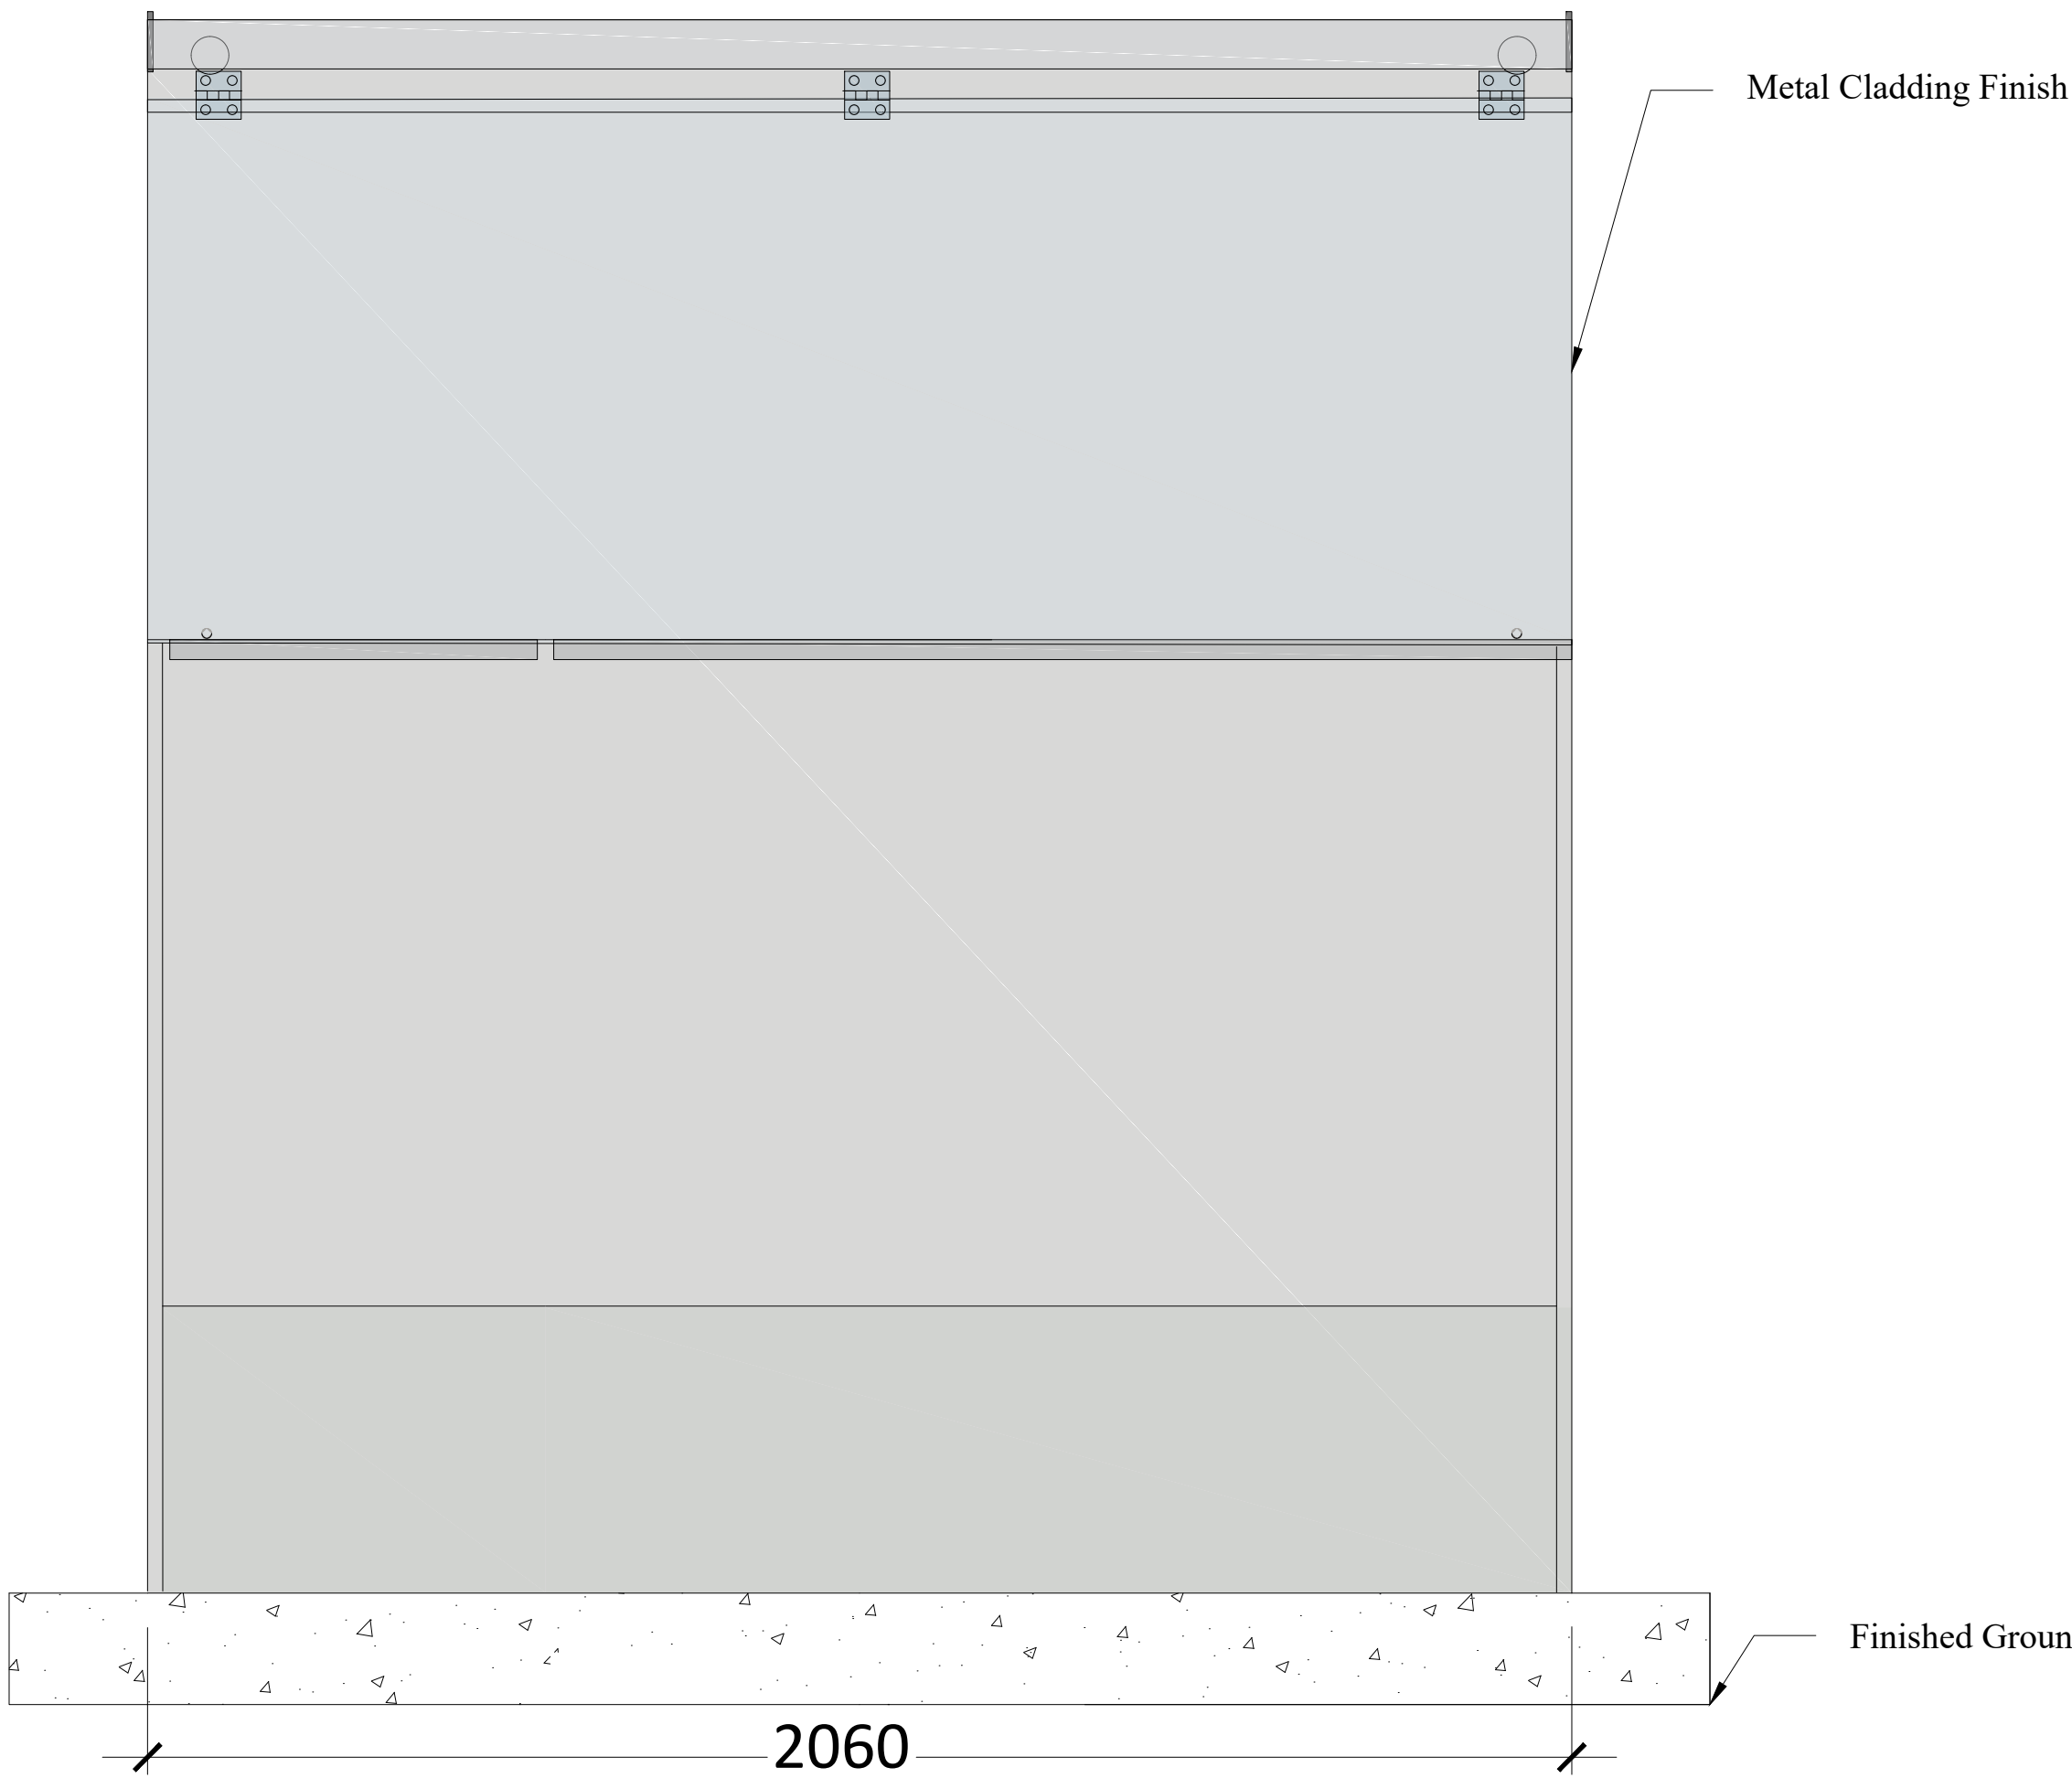

RMU Front Elevation  
SCALE: 1:10

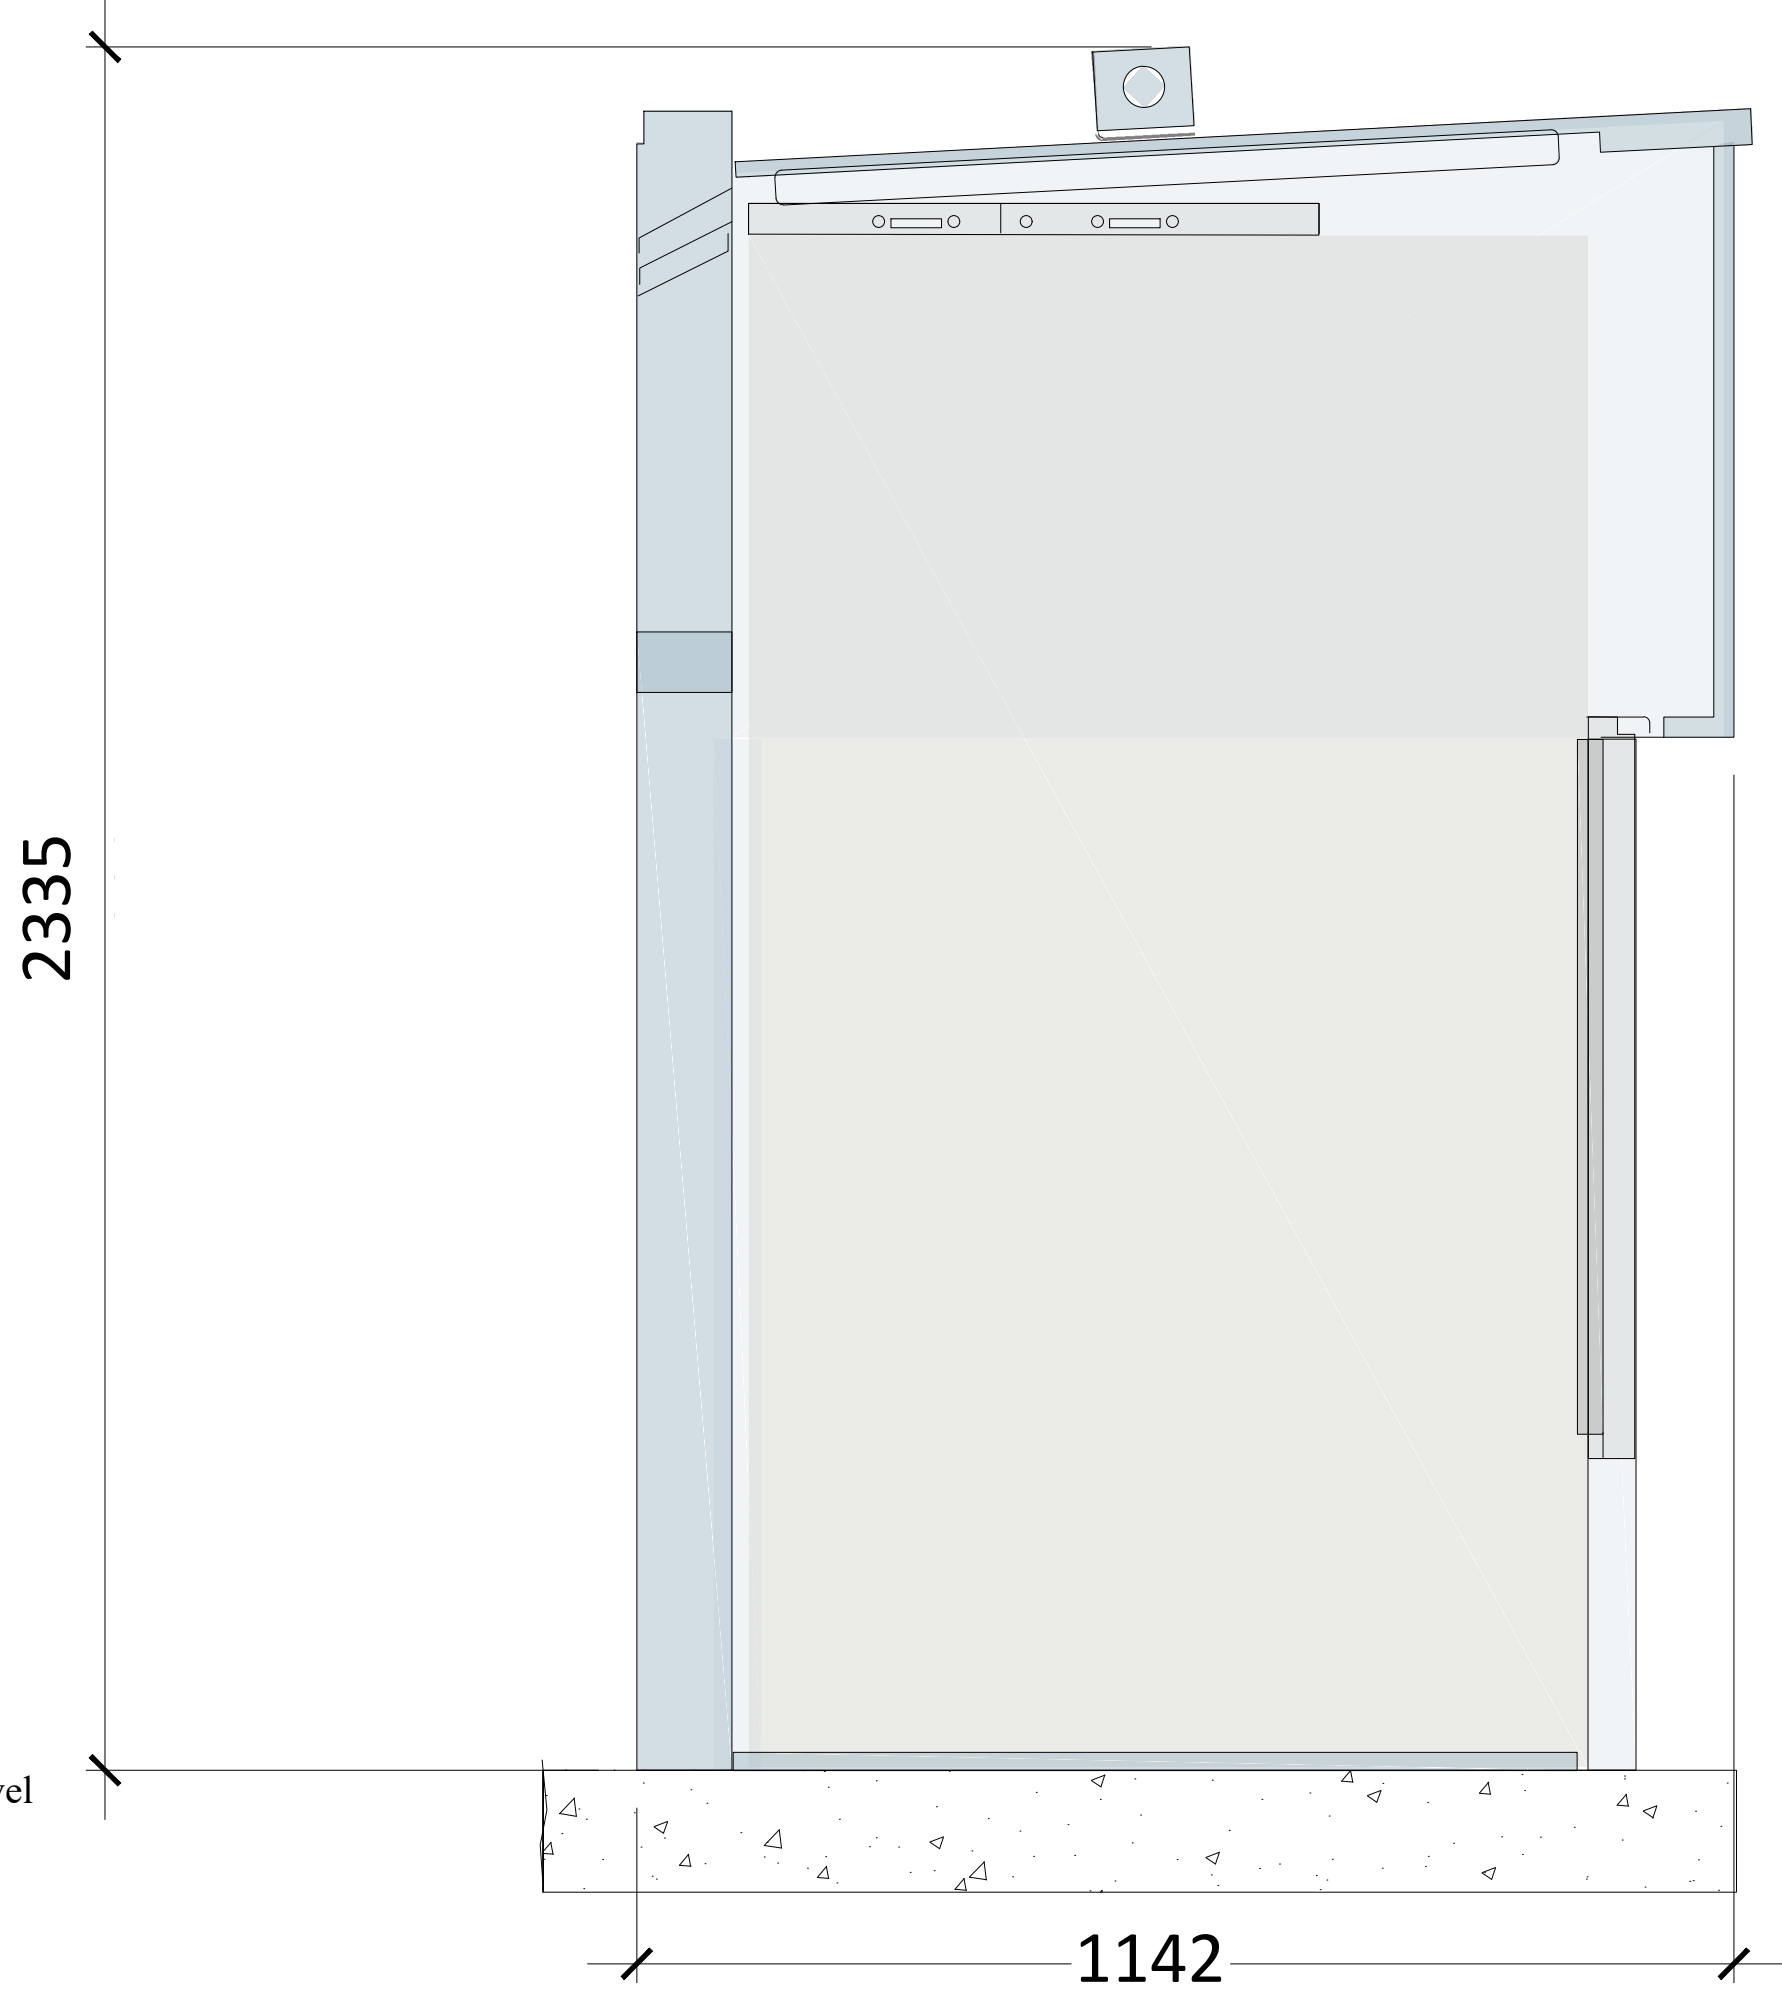

RMU Side Elevation  
SCALE: 1:10



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PROJECT  
Shancloon 110kV Substation

CLIENT  
RWE

CONSULTANTS

- NOTES: -
- This drawing is to be read in conjunction with relevant drawings, specifications and reports.
  - Drawings are not to be scaled use figured dimensions only.
  - All dimensions in millimetres
  - Pad footing indicative and subject to detailed site investigation and design
  - Dimensions shown are typical, final dimensions of RMU subject to detailed design.
  - Refer to the Site Layout Plans for north point and FFL
- LEGEND: -

ISSUE/REVISION		
P00	09.07.25	Issued for Planning
N1	20.05.24	Issued for Information
I/R	DATE	DESCRIPTION

PROJECT NUMBER  
05-1021

SHEET TITLE  
Typical 33kV RMU Elevations

SHEET NUMBER  
051021-DR-310